



TRENCH & PAVER PATH DETAIL
SCALE: 1:20mm

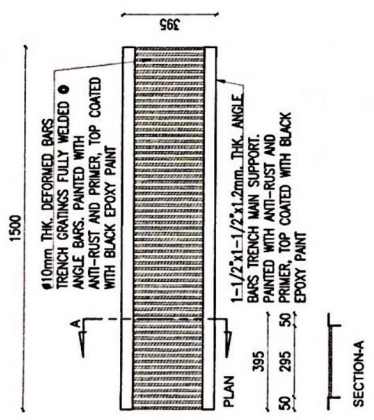


TRENCH FABRICATION DETAIL
SCALE: 1:20mm

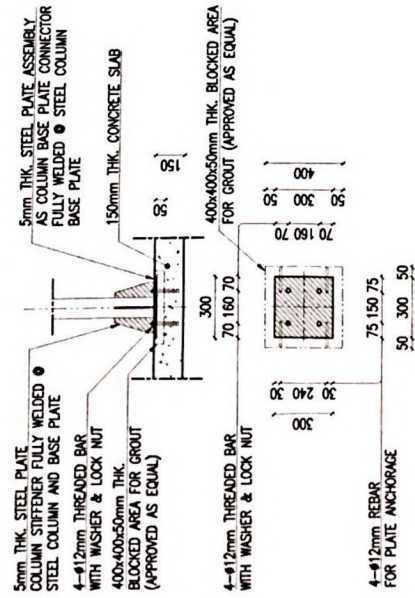


DETAIL - Z
SCALE: 1:20mm

	REPUBLIC OF THE PHILIPPINES UNIVERSITY OF SCIENCE & TECHNOLOGY OF SOUTHERN PHILIPPINES C. Y. Reyes Avenue, Linaoagan, 9000 Cotabato City Tel. Nos. (08327) 71-66-65 / (083) 844-7174 / 844-7179 Fax No. (083) 844-6486 Web Site: www.ustip.edu.ph		PREPARED BY: ENGR. MICHELLE HERBES (PR NO. / TR NO. / DATE ISSUED)	PROJECT: PROPOSED STUDENT STUDY SHED-2 LOCATION: C.M. RECTO AVENUE, LINAAGAN, CAGAYAN DE ORO CITY OWNER: UNIVERSITY OF SCIENCE & TECHNOLOGY OF SOUTHERN PHILIPPINES	RECOMMENDED APPROVAL: ATTY. JONATHAN S. COCHE <small>VICE CHANCELLOR FOR FINANCE & ADMINISTRATION</small>	APPROVED BY: ARLY DOMINGO ALINA <small>PROJECT & PARTICIPANT DETAIL</small>	SHEET CONTENTS: SHEET NO. S3 DRAWN BY: COCHE DATE: 2002/2022 CHECKED BY: JONATHAN S. COCHE DATE: 2002/2022 PLOT DATE: 7/6/22 SCALE: 1:20mm
--	---	--	--	---	---	---	--

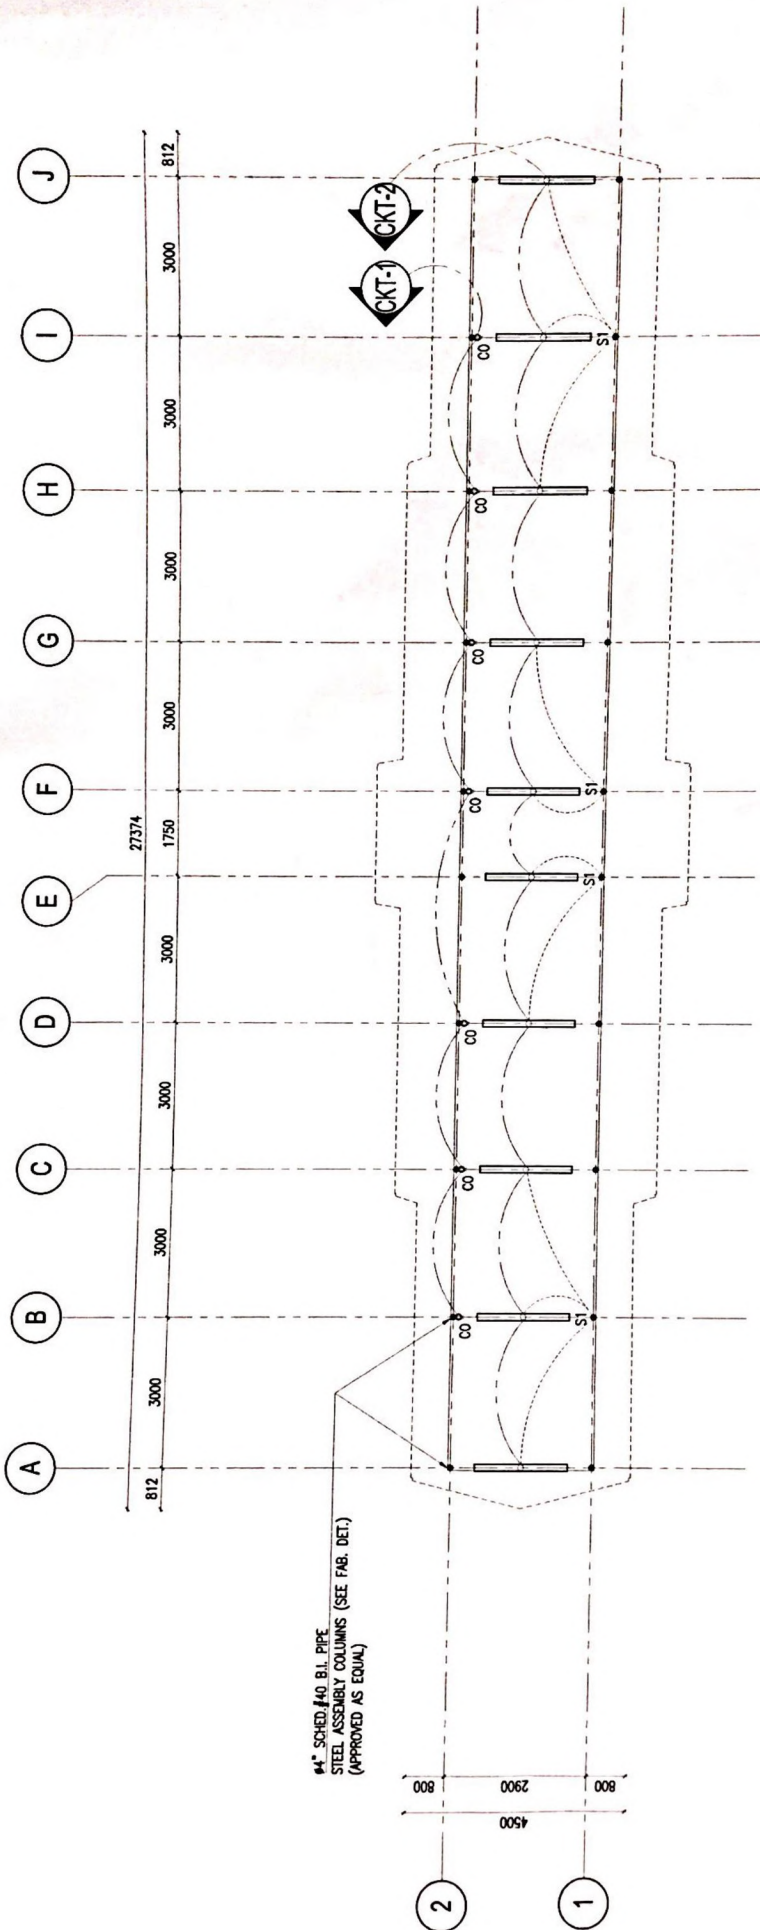


STUDY SHED-1 ROOF FRAMING PLAN
SCALE: 1:100

	REPUBLIC OF THE PHILIPPINES UNIVERSITY OF SCIENCE & TECHNOLOGY OF SOUTHERN PHILIPPINES C. M. RECTO AVENUE, LAPANAN, 9000 CAGAYAN DE ORO CITY Tel. Nos. (08827) 70-6648 / (088) 854-1738 / 854-1739 9000 City www.ustip.edu.ph	PREPARED BY: ENGR. ANDRE J. C. NERI, P. REG. NO. _____ TIN NO. _____ DATE ISSUED: _____	PROJECT: PROPOSED STUDENT STUDY SHED-2 LOCATION: C. M. RECTO AVENUE, LAPANAN, CAGAYAN DE ORO CITY OWNER: UNIVERSITY OF SCIENCE & TECHNOLOGY OF SOUTHERN PHILIPPINES	RECOMMENDING APPROVAL: ATTY. JONATHAN S. DORE REG. NO. _____ TIN NO. _____ DATE ISSUED: _____	APPROVED BY: ATTY. JONATHAN S. DORE REG. NO. _____ TIN NO. _____ DATE ISSUED: _____	SHEET CONTENTS: ROOF FRAMING PLAN	DRAWN BY: GONE DATE: 28/02/2022 CAD BY: indigopanda SHEET CHECKED: 28/02/2022 PLOT DATE: 18/02 SCALE: 1:100mm	
--	---	---	--	---	---	--------------------------------------	--	--

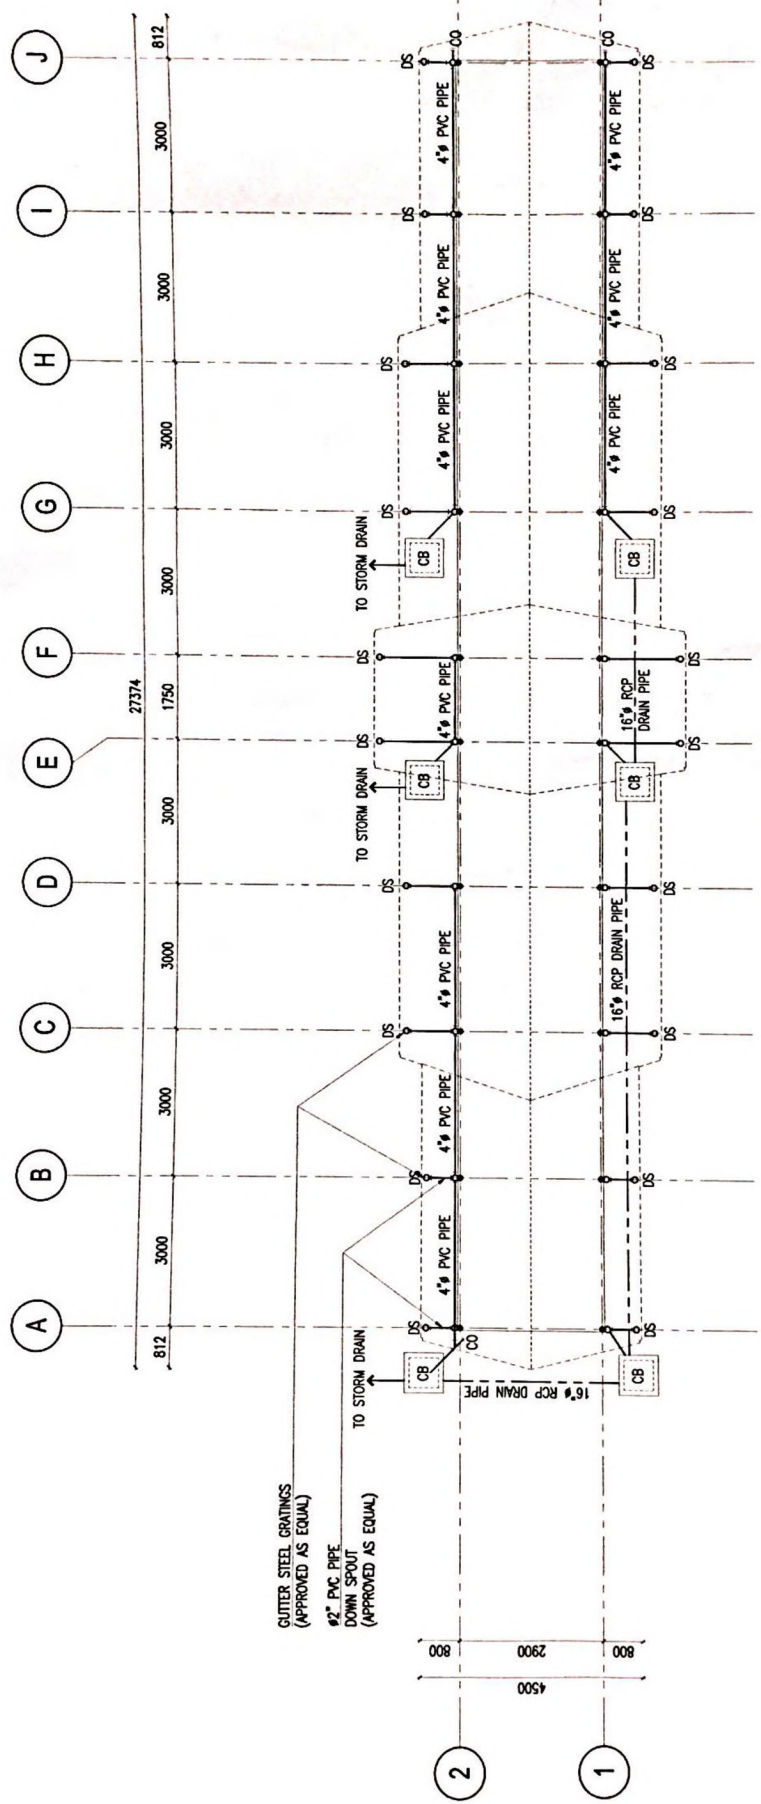


STUDY SHED - DOWN SPOUT LAYOUT
SCALE: 1:100

	REPUBLIC OF THE PHILIPPINES UNIVERSITY OF SCIENCE & TECHNOLOGY OF SOUTHERN PHILIPPINES C. M. Recto Avenue, Lapanan, Cagayan de Oro City 9000 Tel. # 1 (088) 844-1000 / 1 (088) 844-1001 / 1 (088) 844-1002 / 1 (088) 844-1003 Fax # 1 (088) 844-1004 Web Site: www.ustp.edu.ph	PREPARED BY: ENGR. ANGELO Z. NERI, Jr. USTP ID NO.: USTP ID NO.: USTP ID NO.: USTP ID NO.:	PROJECT: PROPOSED STUDENT STUDY SHED-2	RECOMMENDING APPROVAL: ENGR. ANGELO Z. NERI, Jr. USTP ID NO.:	RECOMMENDING APPROVAL: ENGR. ANGELO Z. NERI, Jr. USTP ID NO.:	APPROVED BY: ENGR. ANGELO Z. NERI, Jr. USTP ID NO.:	SHEET CONTENTS: DOWN SPOUT LAYOUT	DRAWN BY: GOME DATE: 2020/02/22 CAD BY: ANGELO Z. NERI, Jr. Date Checked: 2020/02/22 PLOT DATE: 7/6/22 SCALE: 1:100mm	SHEET NO. P1
--	--	---	--	---	---	---	--------------------------------------	--	------------------------

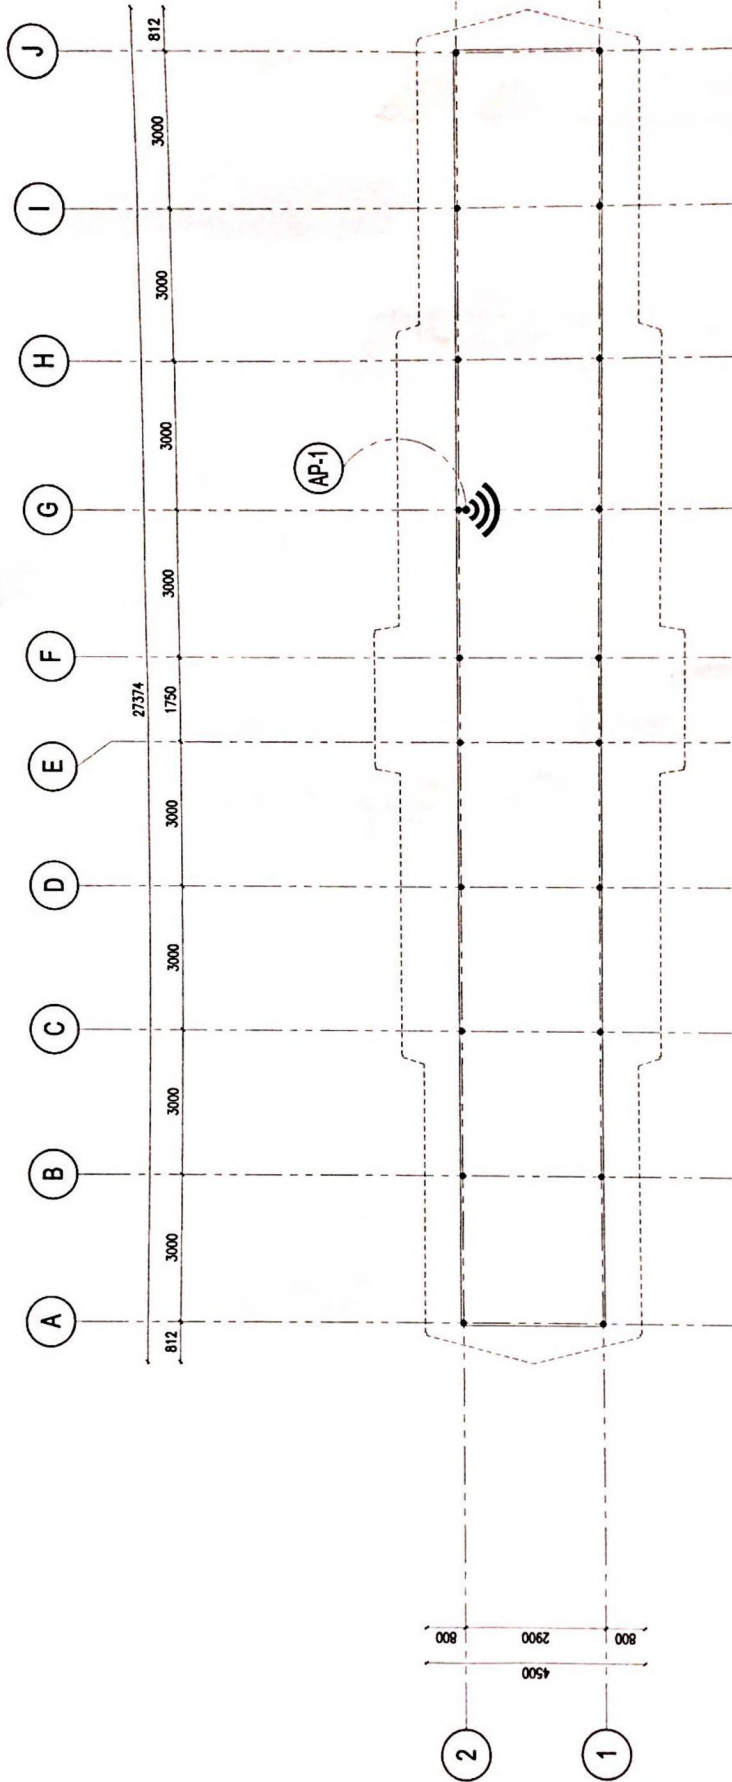


ELECTRONICS PLAN
SCALE 1:100

<p>REPUBLIC OF THE PHILIPPINES UNIVERSITY OF SCIENCE & TECHNOLOGY OF SOUTHERN PHILIPPINES CAGAYAN DE ORO CITY 9000</p> <p>C. M. Recto Avenue, Lapanan, 9000 Cagayan de Oro City Tel. Nos. (08822) 74-6648 / (088) 864-1758 / 864-1759 Fax No. (08822) 74-6648 WWW.USTP.PH</p>	<p>PREPARED BY: ENGR. ANICETO, NERI J. PROJECT NO. _____ DATE ISSUED _____</p>	<p>PROJECT: PROPOSED STUDENT STUDY SHED-2</p>	<p>RECOMMENDING APPROVAL: ATTY. JONATHAN S. COCA ATTY. DOMINIC O. ALERNA</p>	<p>APPROVED BY: </p>	<p>SHEET CONTENTS: ELECTRONICS PLAN</p>	<p>DRAWN BY: GOME DATE: 20/02/2022 CAD BY: JUAN MIGUEL CHK: CHERRY MARIE S. OZUNA PRG DATE: 20/02/2022 SCALE: 1:100/mm</p>	<p>SHEET NO. Ec1</p>
	<p>UNIVERSITY OF SCIENCE & TECHNOLOGY OF SOUTHERN PHILIPPINES CAGAYAN DE ORO CITY 9000</p>	<p>LOCATION: C. M. RECTO AVENUE, LAPANAN, CAGAYAN DE ORO CITY OWNER: UNIVERSITY OF SCIENCE & TECHNOLOGY OF SOUTHERN PHILIPPINES</p>	<p>RECOMMENDING APPROVAL: </p>	<p>APPROVED BY: </p>	<p>DATE: 20/02/2022 CHK: CHERRY MARIE S. OZUNA PRG DATE: 20/02/2022</p>	<p>SCALE: 1:100/mm</p>	<p>SHEET NO. Ec1</p>

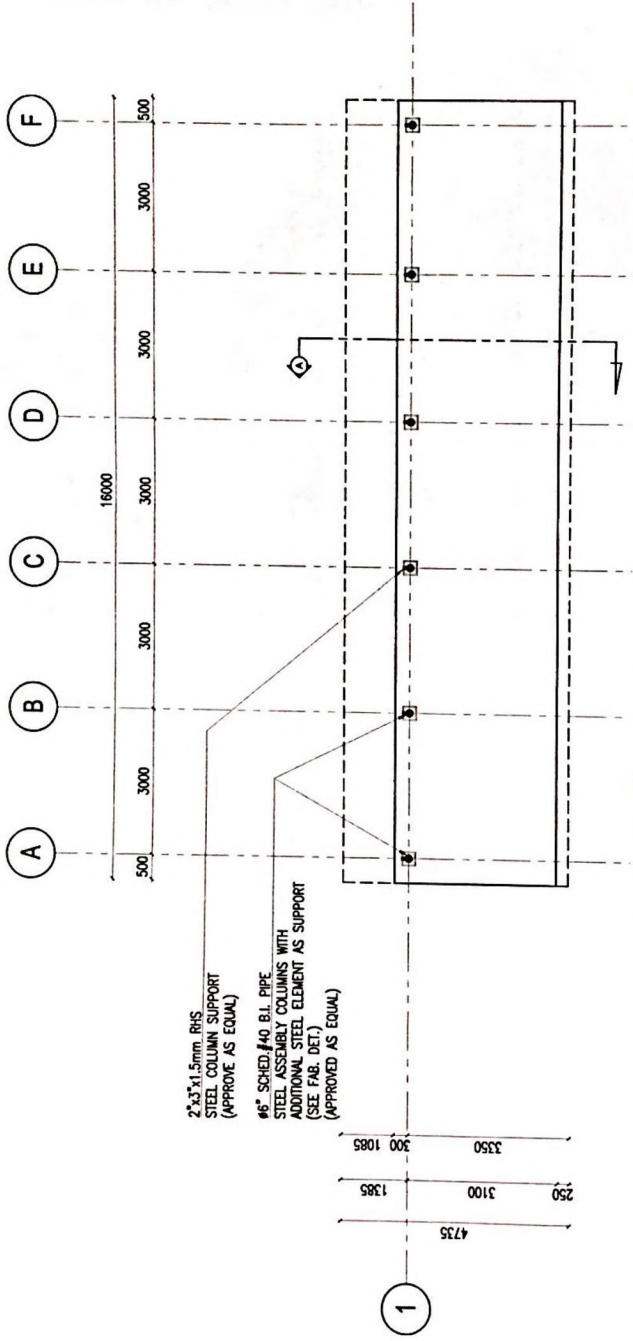

PERFORMING SHED FLOOR PLAN
SCALE: 1:100


	REPUBLIC OF THE PHILIPPINES UNIVERSITY OF SCIENCE & TECHNOLOGY OF SOUTHERN PHILIPPINES C. M. Recto Avenue, Lapasan 9000 Cotabato City Tel. Nos. (08827) 72-00-00 / (0880) 884-1738 / 884-1739 Fax No. (08827) 72-00-00 Email: usstp@ustp.edu.ph	PREPARED BY: ENGR. ANSELMO MERRI JR. PROJECT NO.: SHEET NO.:	PROJECT: PROPOSED STUDENT STUDY SHED-2 LOCATION: C. M. RECTO AVENUE, LAPASAN, COTABATO CITY OWNER: UNIVERSITY OF SCIENCE & TECHNOLOGY OF SOUTHERN PHILIPPINES	RECOMMENDING APPROVAL: ATTY. JONATHAN S. OCHO VICE CHANCELLOR FOR FINANCE & ADMINISTRATION	APPROVED BY: ATTY. JONATHAN S. OCHO VICE CHANCELLOR FOR FINANCE & ADMINISTRATION	SHEET CONTENTS: PERFORMING SHED PLAN	DRAWN BY: GOME DATE: 28/02/2022 CAD BY: ANSELMO MERRI JR. DATE CHECKED: 28/02/2022 PROJECT NO.: 78022 SCALE: 1:100mm	SHEET NO.: A6 A
--	--	---	---	--	--	---	---	------------------------------

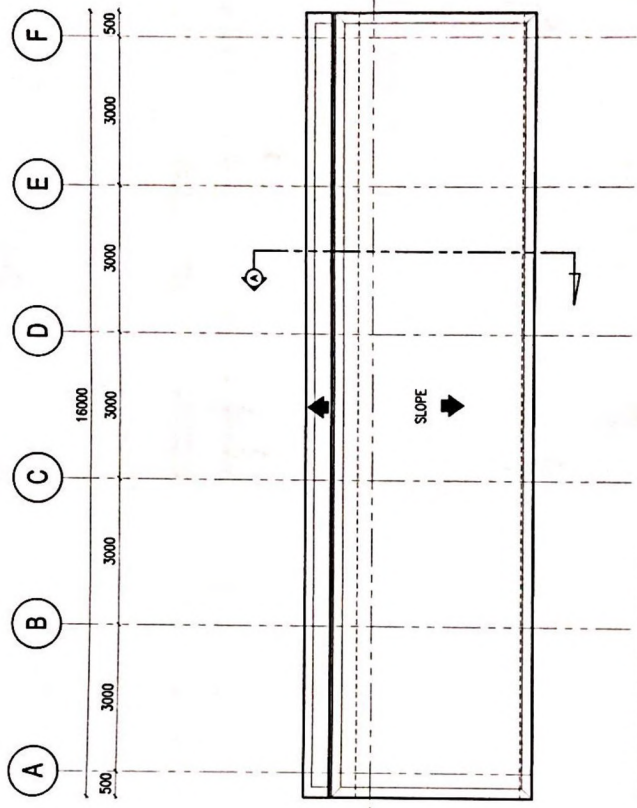


PERFORMING SHED ROOF PLAN
SCALE: 1/100 MM

	REPUBLIC OF THE PHILIPPINES UNIVERSITY OF SCIENCE & TECHNOLOGY OF SOUTHERN PHILIPPINES CAGAYAN DE ORO CITY 8000 C. M. Recto Avenue, Larcade 8000 Cebu City Tel. Nos: (08832) 79-00-00 / 0080 894-1739 / 894-1739 8000 C. M. Recto Ave. C. O. CAGAYAN DE ORO CITY 8000	PREPARED BY: ENGR ANASTAS NERI JR. P. NO.: P. NO.: P. NO.:	PROJECT: PROPOSED STUDENT STUDY SHED-2 LOCATION: C.M RECTO AVENUE LARCANE, CAGAYAN DE ORO CITY OWNER: UNIVERSITY OF SCIENCE & TECHNOLOGY OF SOUTHERN PHILIPPINES	RECOMMENDING APPROVAL: RECOMMENDING APPROVAL: ATTY. JONATHAN S. COE <small>NOT VALID FOR THE PURPOSES OF REGISTERING</small>	SHEET CONTENTS: ROOF PLAN	DRAWN BY: GOME DATE: 28/02/2022 CHECKED BY: ANASTAS NERI JR. NAME: ANASTAS NERI JR. REG. NO.: 19022 SCALE: 1:100mm	SHEET NO: A7 A
--	---	--	--	---	------------------------------	---	-----------------------------


NOTE:
 > ALL DISCREPANCIES IN LENGTH/DIMENSIONS ARE SUBJECT TO BE CONFIRMED IN SECTIONS. (ANY UNCLEAR/CONFUSING NUMBERS ARE SUBJECT TO BE RE-EVALUATED BY THE CSNS OFFICE)

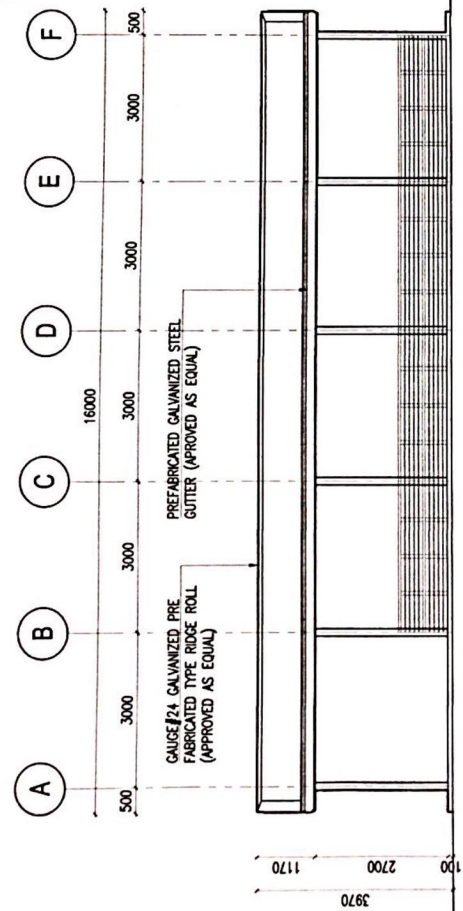


PERFORMING SHED FRONT ELEVATION
 SCALE: 1/100 MM

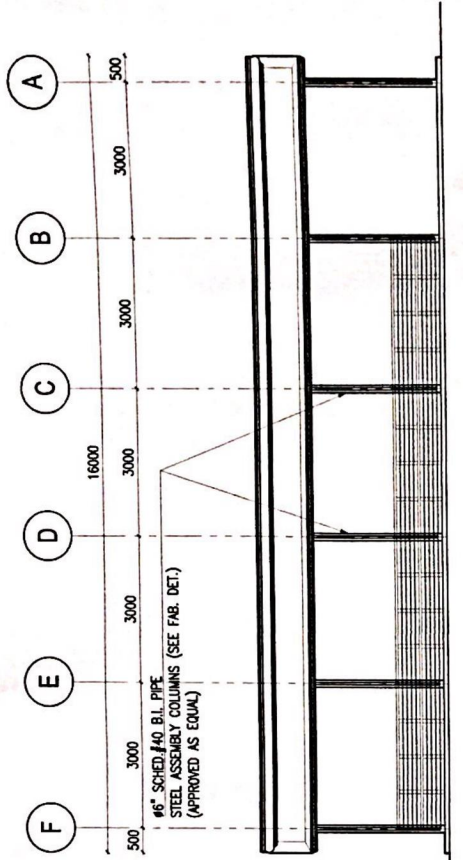


PERFORMING SHED REAR ELEVATION
 SCALE: 1/100 MM

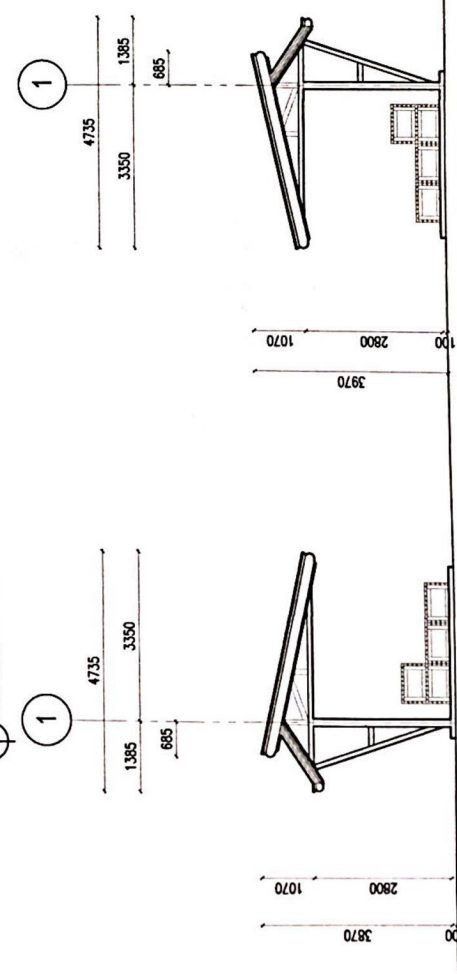

PERFORMING SHED LEFT SIDE ELEVATION
 SCALE: 1/100 MM

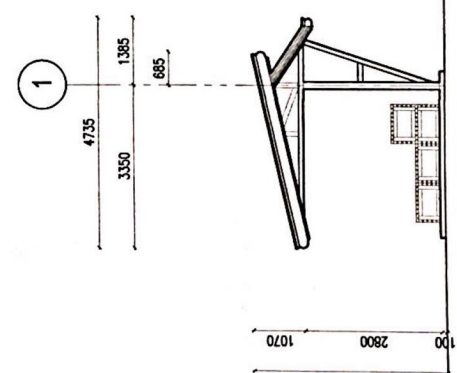


PERFORMING SHED RIGHT SIDE ELEVATION
 SCALE: 1/100 MM

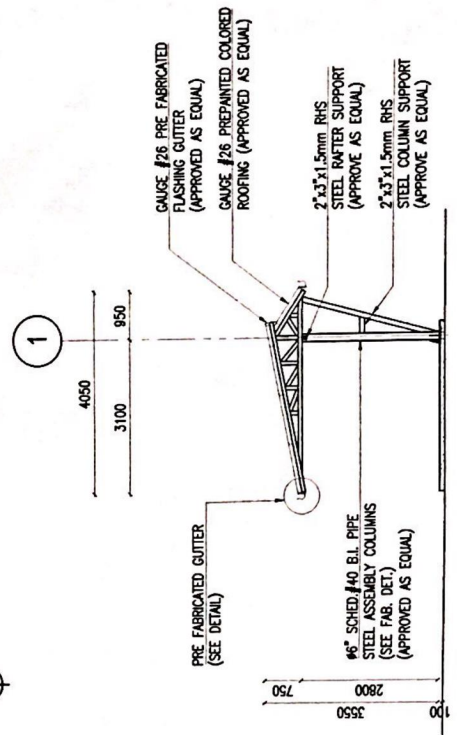


SECTION - A
 SCALE: 1/100 MM

	REPUBLIC OF THE PHILIPPINES UNIVERSITY OF SCIENCE & TECHNOLOGY OF SOUTHERN PHILIPPINES C. M. Recto Avenue, Lapasan, Cagayan de Oro City Tel. No. (088) 884-4040 / (088) 884-4138 / (088) 884-4139 Fax No. (088) 884-4049 Web Site: www.ustip.edu.ph		PREPARED BY: ENR ANICETO J. DELA CRUZ ARCHITECT REG. NO. 10000 (PROF. REG.)	PROJECT: PROPOSED STUDENT STUDY SHED-2	RECOMMENDING APPROVAL: ATTY. JONATHAN S. COLE BAR NO. 100000 (PHILIPPINE BAR)	SHEET CONTENTS: FRONT ELEVATIONS REAR ELEVATIONS LEFT SIDE ELEVATIONS RIGHT SIDE ELEVATIONS SECTION - A	DRAWN BY: GONE DATE: 28/02/2022 CAD BY: ANICETO J. DELA CRUZ DATE: 28/02/2022 PLOT DATE: 17/02/2022 SCALE: 1/100mm	SHEET NO. A8 A
	OWNER: UNIVERSITY OF SCIENCE & TECHNOLOGY OF SOUTHERN PHILIPPINES		LOCATION: C. M. RECTO AVENUE, LAPASAN, CAGAYAN DE ORO CITY	RECOMMENDING APPROVAL: ATTY. JONATHAN S. COLE BAR NO. 100000 (PHILIPPINE BAR)	APPROVED BY: ATTY. JONATHAN S. COLE BAR NO. 100000 (PHILIPPINE BAR)	APPROVED BY: GONE DATE: 28/02/2022 CAD BY: ANICETO J. DELA CRUZ DATE: 28/02/2022 PLOT DATE: 17/02/2022 SCALE: 1/100mm	SHEET NO. A8 A	

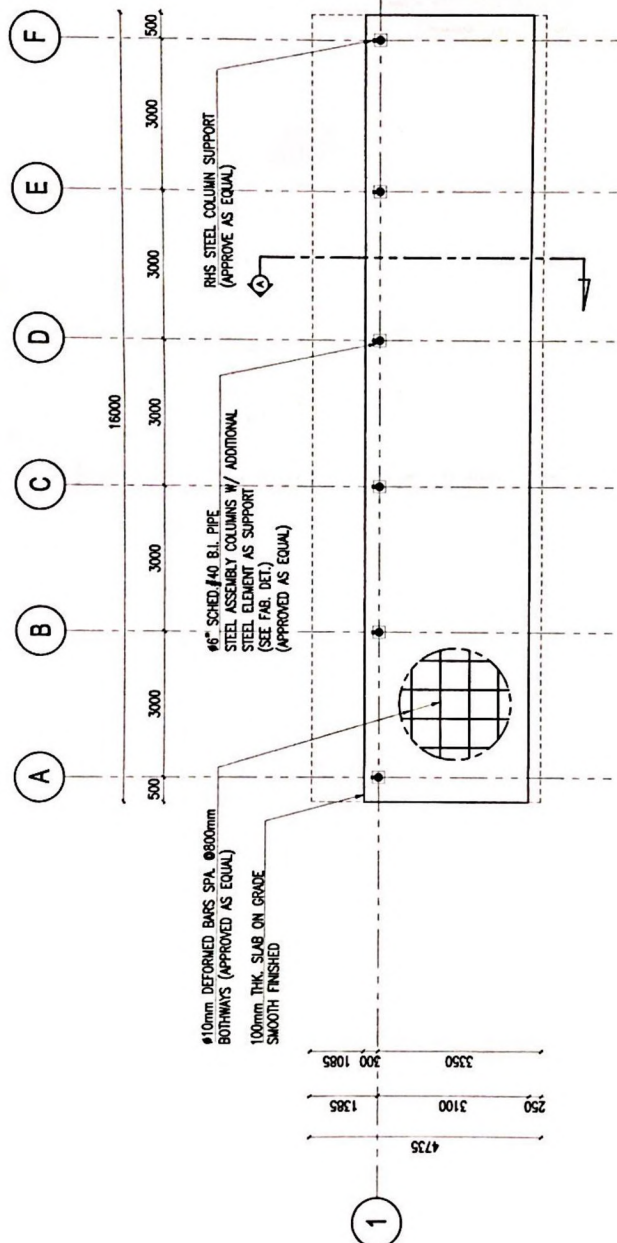


PERFORMING SHED PLATFORM LAYOUT

	REPUBLIC OF THE PHILIPPINES UNIVERSITY OF SCIENCE & TECHNOLOGY OF SOUTHERN PHILIPPINES C.M. Recto Avenue, Lapanan 9000 Cagayan de Oro City Tel. No. (088) 221-71-800-4 / (088) 866-1738 / 866-1739 Fax No. (088) 221-71-800-5 Email: ustip@ustip.edu.ph	PROJECT: PROPOSED STUDENT STUDY SHED-2 LOCATION: C.M. RECTO AVENUE LAPANAN CAGAYAN DE ORO CITY OWNER: UNIVERSITY OF SCIENCE & TECHNOLOGY OF SOUTHERN PHILIPPINES	PREPARED BY: ENGR. MARICEL M. BARRERA ENR. NO. 100-100000-100000 REG. NO. 100-100000-100000 DATE: 2022-02-22	RECOMMENDING APPROVAL: ENGR. MARICEL M. BARRERA CIVIL ENGINEER REG. NO. 100-100000-100000	RECOMMENDING APPROVAL: ATTY. JONATHAN S. COCHE BAR NO. 100-100000-100000	APPROVED BY: CITY ENGINEER ARNOLD ALISMA REG. NO. 100-100000-100000	SHEET CONTENTS: PLATFORM LAYOUT	DRAWN BY: GONE DATE: 2022/02/22 CAD BY: MARICEL M. BARRERA JOB NUMBER: 20220222 PLOT DATE: 7/6/22 SCALE: 1:100mm	SHEET NO. S1 A
--	--	--	--	--	--	---	------------------------------------	---	----------------------

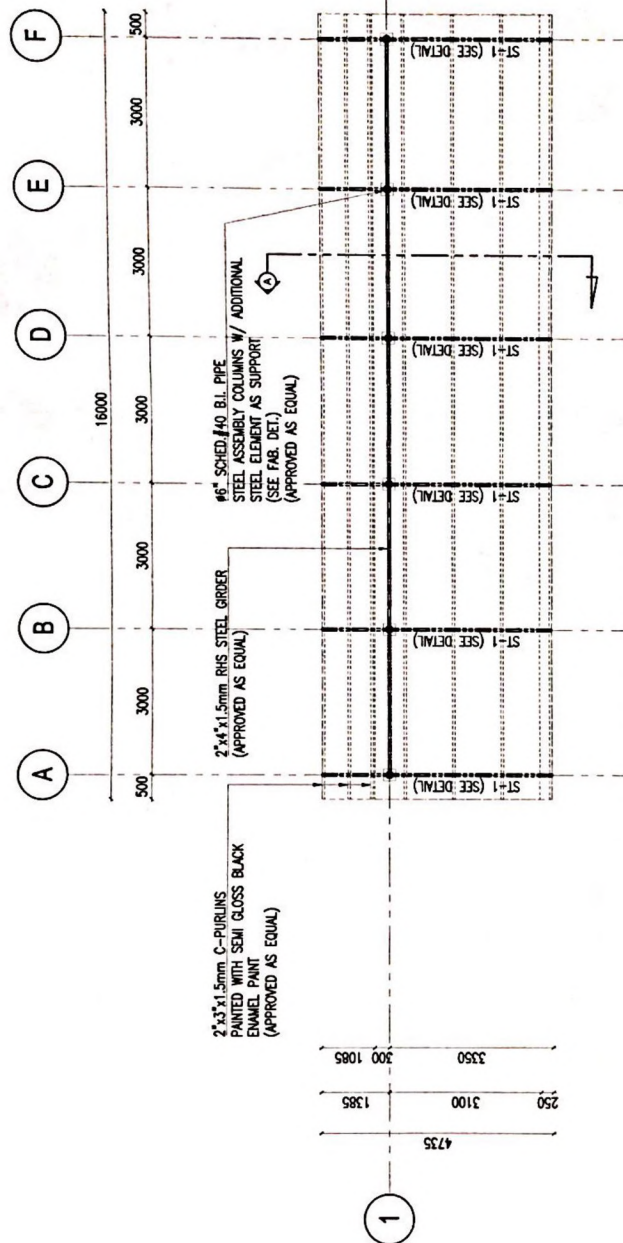


PERFORMING SHED ROOF FRAMING PLAN
SCALE: 1:100

<p>UNIVERSITY OF THE PHILIPPINES UNIVERSITY OF SCIENCE & TECHNOLOGY OF SOUTHERN PHILIPPINES C. M. Recto Avenue, Davao City 8000 Tel. Fax: (088) 744-4444 / (088) 744-1744 / (088) 744-1744 / (088) 744-1744 800 511 1000 (toll-free)</p>	<p>PREPARED BY: ENGR. ANGELO J. NEFI, P. DATE ISSUED: _____</p>	<p>PROJECT: PROPOSED STUDENT STUDY SHED-2</p>	<p>APPROVED BY: <i>[Signature]</i> ATTY. WYNTHAN S. COSE CITY ENGINEER, D. ALBINA CITY ENGINEER, URBANIZ VICE CHIEF OF THE PHILIPPINE ENGINEERING BOARD</p>	<p>SHEET NO. S2 A</p>
	<p>UNIVERSITY OF SCIENCE & TECHNOLOGY OF SOUTHERN PHILIPPINES C. M. Recto Avenue, Davao City 8000 Tel. Fax: (088) 744-4444 / (088) 744-1744 / (088) 744-1744 / (088) 744-1744 800 511 1000 (toll-free)</p>	<p>OWNER: UNIVERSITY OF SCIENCE & TECHNOLOGY OF SOUTHERN PHILIPPINES</p>	<p>LOCATION: C. M. RECTO AVENUE, DAVAO CITY</p>	<p>RECOMMENDED APPROVAL: <i>[Signature]</i> ENGR. ANGELO J. NEFI, P. DATE ISSUED: _____</p>

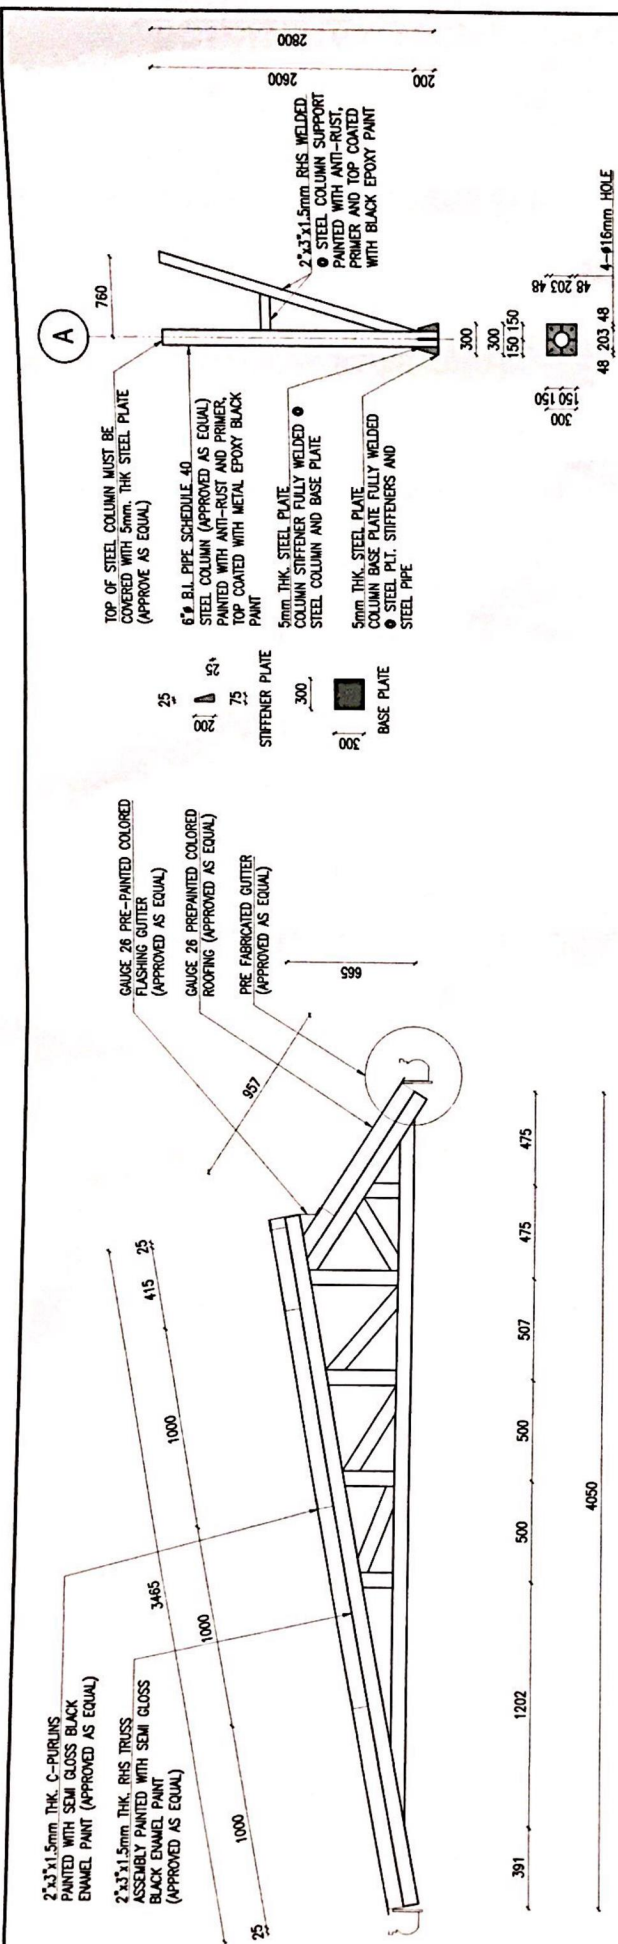

PERFORMING SHED TRUSS DETAIL
SCALE 1:38 MM

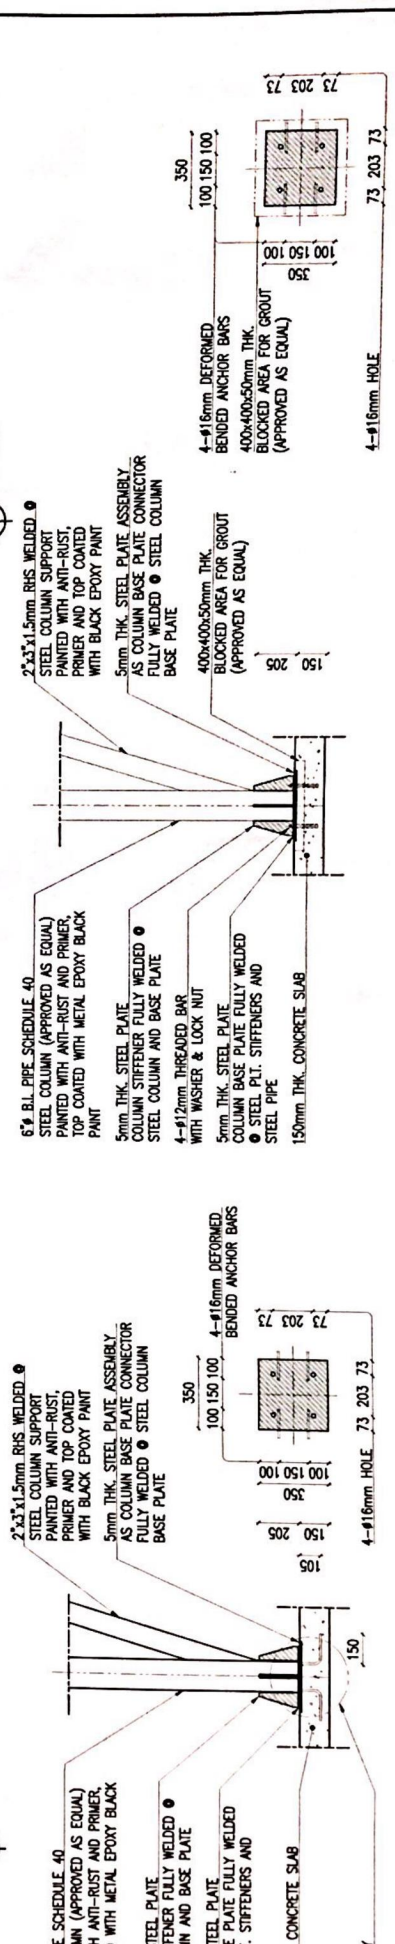

PERFORMING SHED STEEL COLUMN CONNECTION DETAIL
SCALE 1:38 MM

PROPOSED STUDENT STUDY SHED-2

RECOMMENDED APPROVAL		RECOMMENDING APPROVAL		SHEET CONTENTS		OWNER: BY: DOME	SHEET NO:
APPROVED: [Signature]		APPROVED: [Signature]		TRUSS DETAIL		DATE: 28/03/2022	D
APPROVED: [Signature]		APPROVED: [Signature]		STEEL COLUMN DETAIL		CAD BY: INDOOR/INDOOR	S2
APPROVED: [Signature]		APPROVED: [Signature]		STEEL COL. CONNECTION DET.		TEAM CHIEF: 28/03/2022	
APPROVED: [Signature]		APPROVED: [Signature]		DETAIL 'Y'		TEAM CHIEF: 28/03/2022	
APPROVED: [Signature]		APPROVED: [Signature]		CITY (DRAPELO J. ARMA)		SCALE: 1:100mm	
APPROVED: [Signature]		APPROVED: [Signature]		MAYOR (ALFONSO E. ISABIDA)			
APPROVED: [Signature]		APPROVED: [Signature]		CITY ENGINEER (D. ARMA)			
APPROVED: [Signature]		APPROVED: [Signature]		MUNICIPAL ENGINEER			

PREPARED BY: ENGR. ANCELITO MERRI 2

PROJECT: PROPOSED STUDENT STUDY SHED-2



LOCATION: C.M. RECTO AVENUE, LUPATMAN, DAGAPAN DE ORDO CITY

OWNER: UNIVERSITY OF SCIENCE & TECHNOLOGY OF SOUTHERN PHILIPPINES


DATE ISSUED: _____

REPUBLIC OF THE PHILIPPINES
UNIVERSITY OF SCIENCE & TECHNOLOGY OF SOUTHERN PHILIPPINES
C.M. Recto Avenue, Lupatman, Dagupan de Ordo City
Tel. No. (0454) 714-4441 / 7088 / 7089 / 7091 / 7092 / 714
Fax No. (0454) 884-4438
Email: info@ustp.edu.ph

USTP

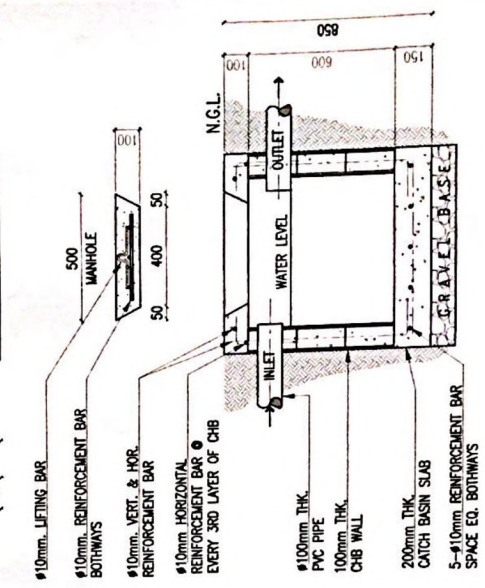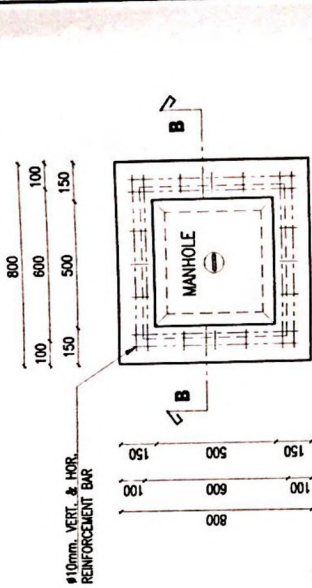


TYPICAL CATCH BASIN DETAIL
SCALE 1:20 MM

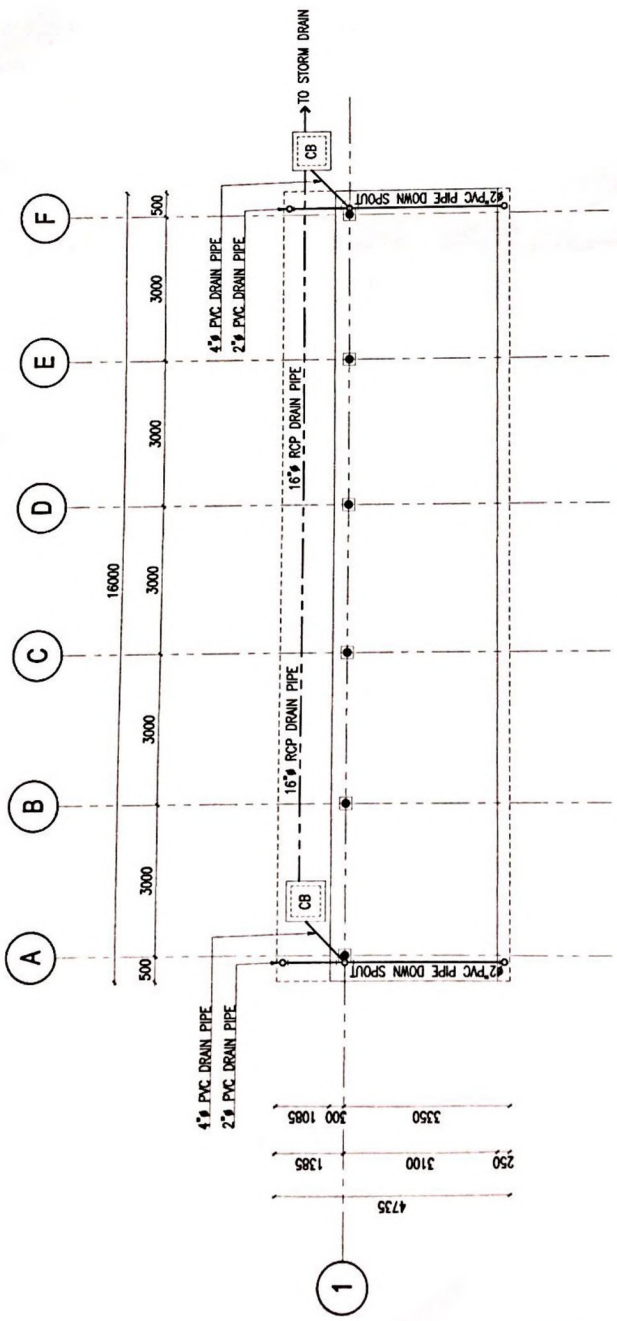

PERFORMING SHED DOWNSPOUT LAYOUT
SCALE 1:20 MM

	UNIVERSITY OF SCIENCE & TECHNOLOGY OF SOUTHERN PHILIPPINES C-11, Bontoc Avenue, Lapanan, CAGAYAN DE ORO CITY Tel. Nos. (08827) 75-66-68 / (0882) 854-1738 / 854-1739 Fax No. (0882) 854-6489 Web Site: www.ustip.edu.ph	PREPARED BY: ENGR. ANGELITO PERA PROJECT NO.: SHEET NO.: DATE ISSUED:	PROJECT: PROPOSED STUDENT STUDY SHED-2 LOCATION: C.M. RECTO AVENUE, LAPANAN, CAGAYAN DE ORO CITY OWNER: UNIVERSITY OF SCIENCE & TECHNOLOGY OF SOUTHERN PHILIPPINES	RECOMMENDING APPROVAL: ATTY. JONATHAN S. GORE UNIVERSITY OF SCIENCE & TECHNOLOGY OF SOUTHERN PHILIPPINES DIRECTOR FOR THE OFFICE OF THE CHIEF ENGINEER	RECOMMENDING APPROVAL: ATTY. JONATHAN S. GORE UNIVERSITY OF SCIENCE & TECHNOLOGY OF SOUTHERN PHILIPPINES DIRECTOR FOR THE OFFICE OF THE CHIEF ENGINEER	SHEET CONTENTS: DOWN SPOUT LAYOUT TYP. CATCH BASIN DETAIL	DRAWN BY: GONE DATE: 28/02/2022 CAD BY: MARICORINDE User: CORBIN28022022 Plot Date: 17/02/2022 SCALE: 1:100mm	SHEET NO.: P1 A
--	---	---	--	---	---	---	--	-------------------------------------

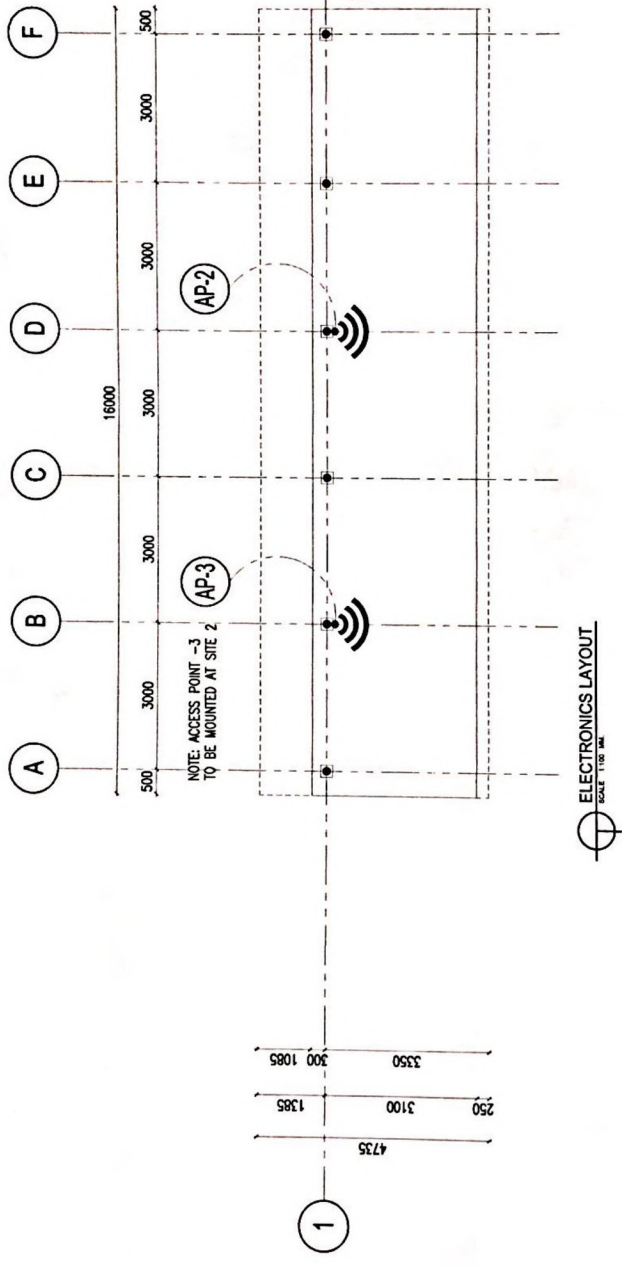

ELECTRONICS LAYOUT
SCALE: 1:100 mm

<p>REPUBLIC OF THE PHILIPPINES UNIVERSITY OF SCIENCE & TECHNOLOGY OF SOUTHERN PHILIPPINES CAGAYAN DE ORO CITY 9000</p> <p>C. M. RECTO AVENUE, LAPASAN, 9000 CAGAYAN DE ORO CITY TEL. Nos. (08822) 72-00-00 / (088) 858-7158 / 858-7159 FAX No. (08822) 72-00-00 WWW.USTIP.EDU.PH</p>	<p>PREPARED BY: ENGR. ANICETO BERLON TECHNOLOGICAL SERVICES DIVISION PINC. NO. _____ TRN. NO. _____</p>	<p>PROJECT: PROPOSED STUDENT STUDY SHED-2</p> <p>LOCATION: C. M. RECTO AVENUE, LAPASAN, CAGAYAN DE ORO CITY OWNER: UNIVERSITY OF SCIENCE & TECHNOLOGY OF SOUTHERN PHILIPPINES</p>	<p>RECOMMENDING AGENCIAL: OFFICE OF THE UNIVERSITY ENGINEER</p> <p>RECOMMENDING APPROVAL: <i>[Signature]</i> ATTY. JONATHAN S. OCHOA UNIVERSITY COUNSELLOR FOR FINANCE & ADMINISTRATION</p>	<p>APPROVED BY: <i>[Signature]</i> ATTY. DONALD C. KIBINA UNIVERSITY COUNSELLOR FOR LEGAL AFFAIRS</p>	<p>BHEET CONTENTS: ELECTRONICS LAYOUT</p>	<p>DRAWN BY: GONE DATE: 28/03/2022</p> <p>CAD BY: zangpangol Date Created: 28/03/2022 Plot Date: 7/4/22 SCALE: 1:100mm</p>	<p>SHEET NO. EC A</p>
---	---	--	---	---	---	--	-------------------------------